




- Notes :**
- All drawings are to be read in conjunction with all relevant Specifications, Bills of Materials, Architectural, Services and Engineering Drawings.
 - Any discrepancies between these documents shall be brought to the attention of the Engineer.
 - All dimensions are in millimetres, unless noted otherwise.
 - All levels are in metres related to Ordnance Datum.
 - Drawings are not to be scaled.

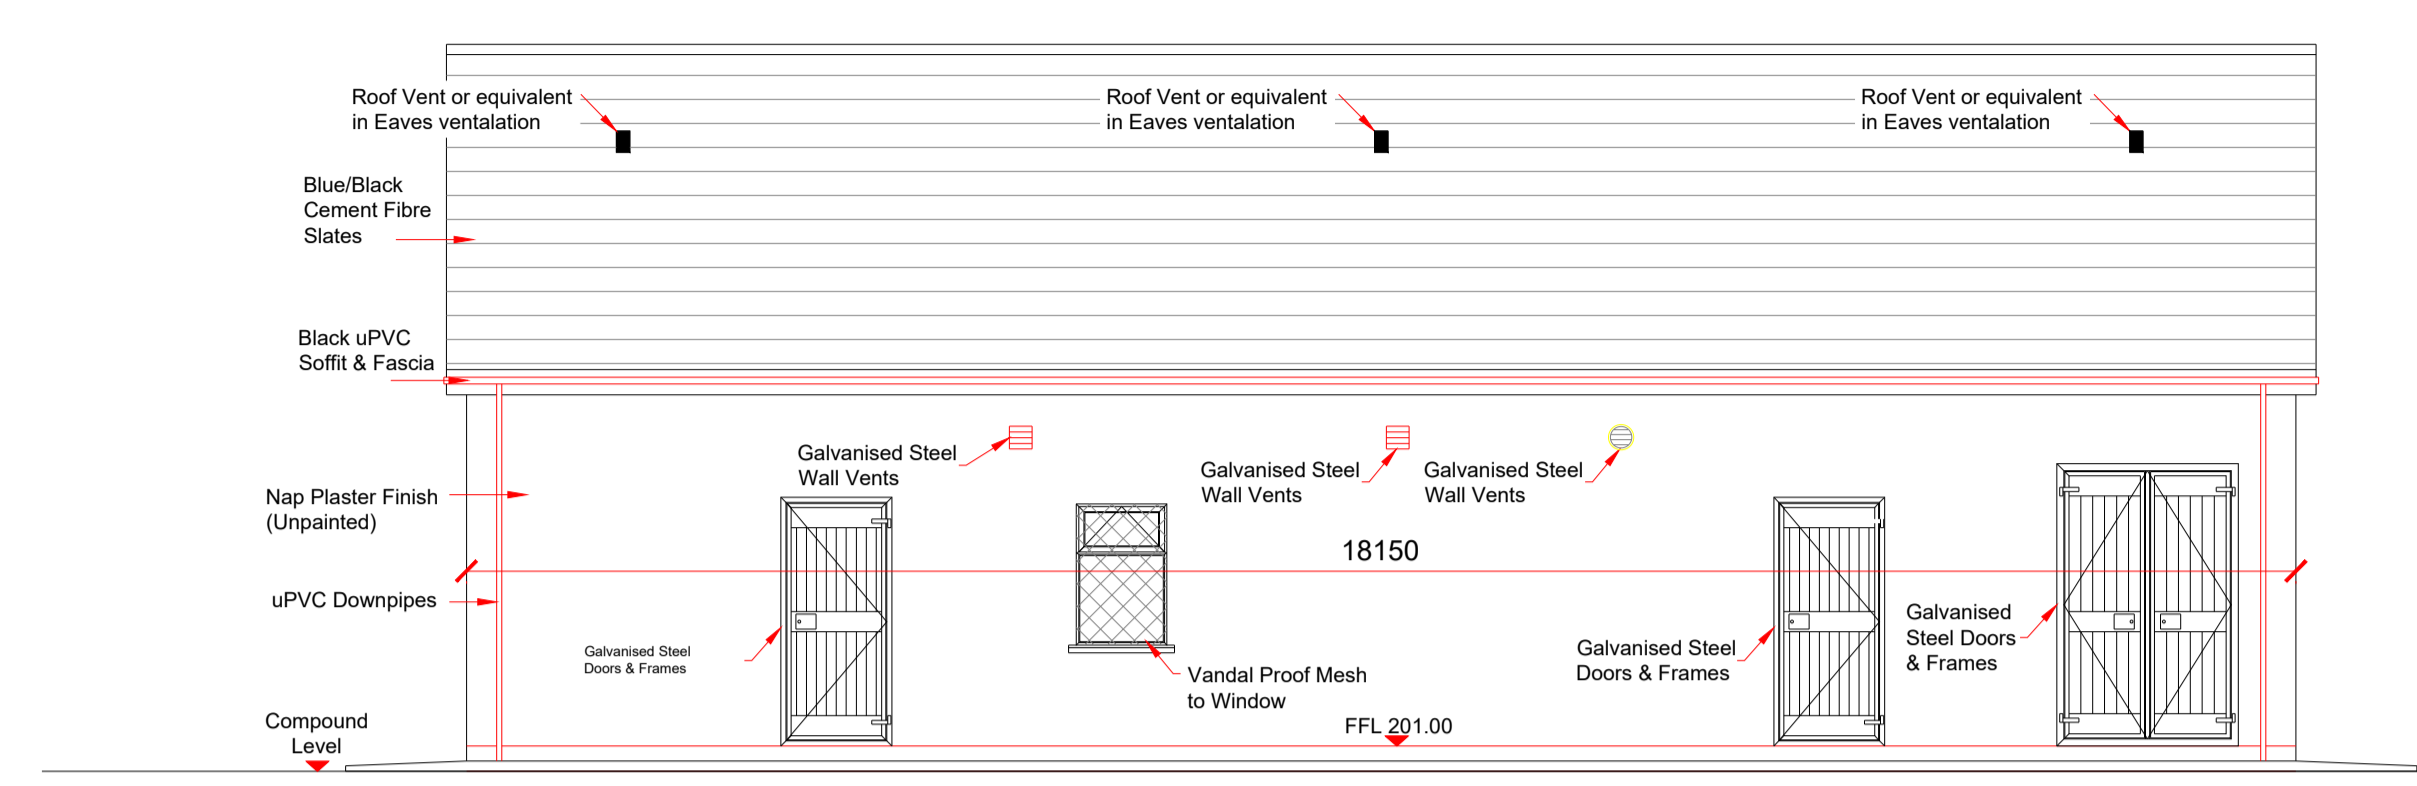


Front Elevation - Southeast Scale 1:75

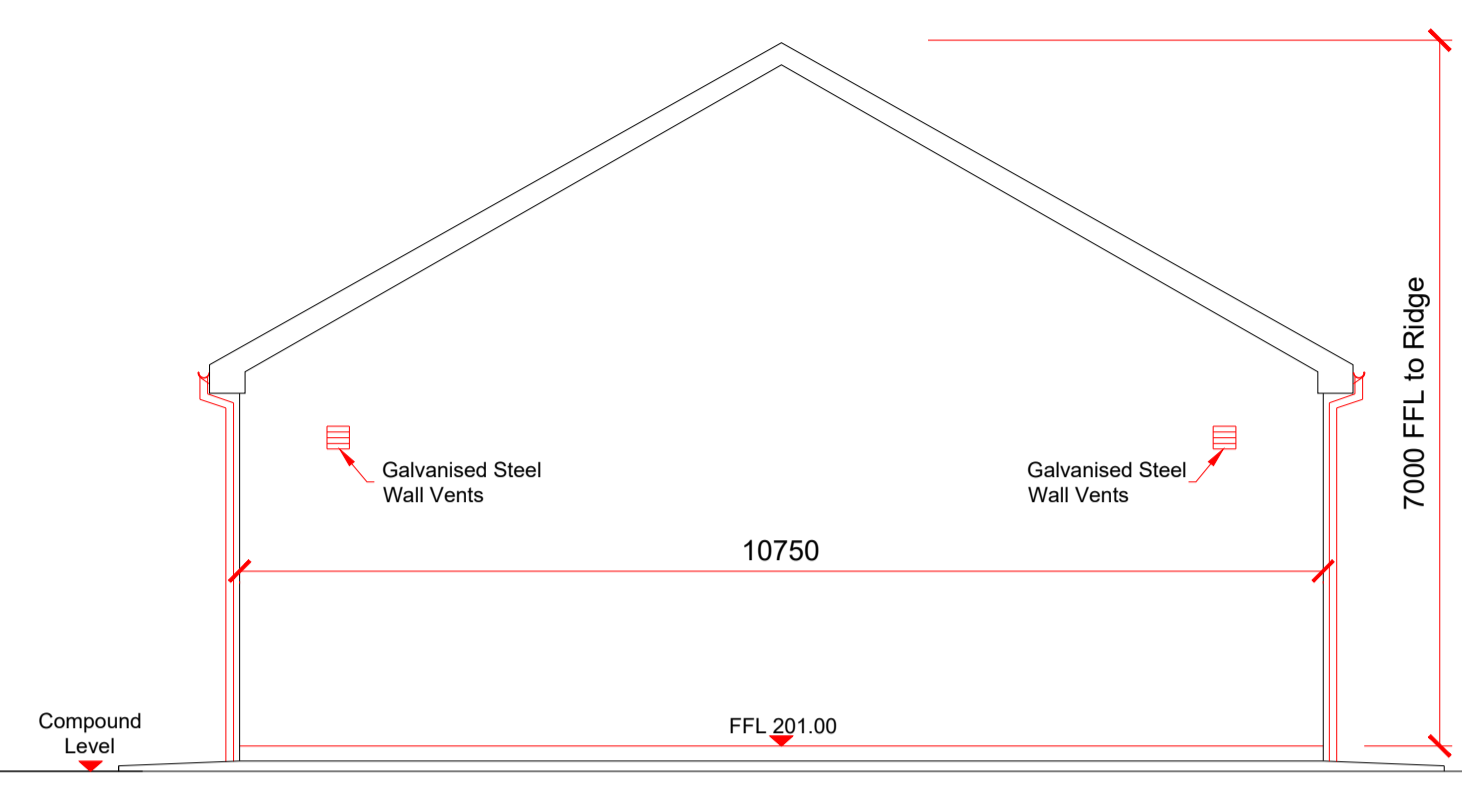


Side Elevation - Northeast Scale 1:75

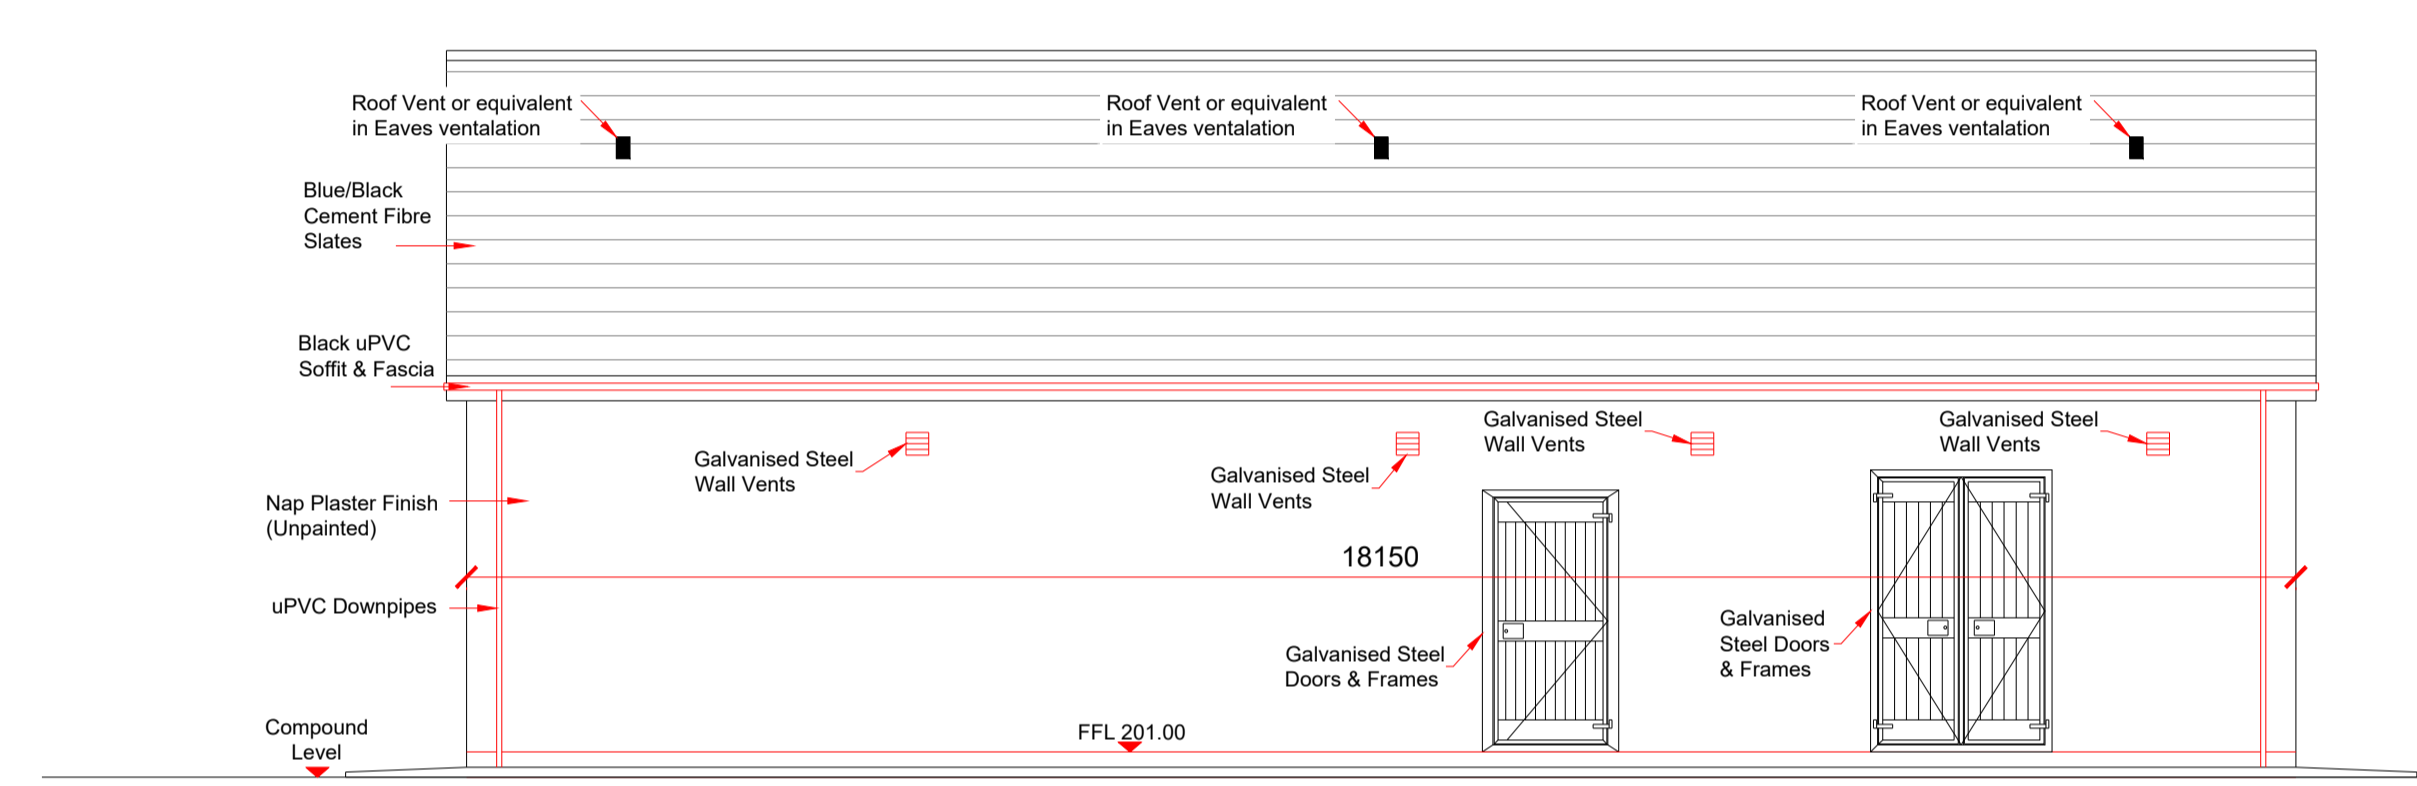



Rear Elevation - Northwest Scale 1:75

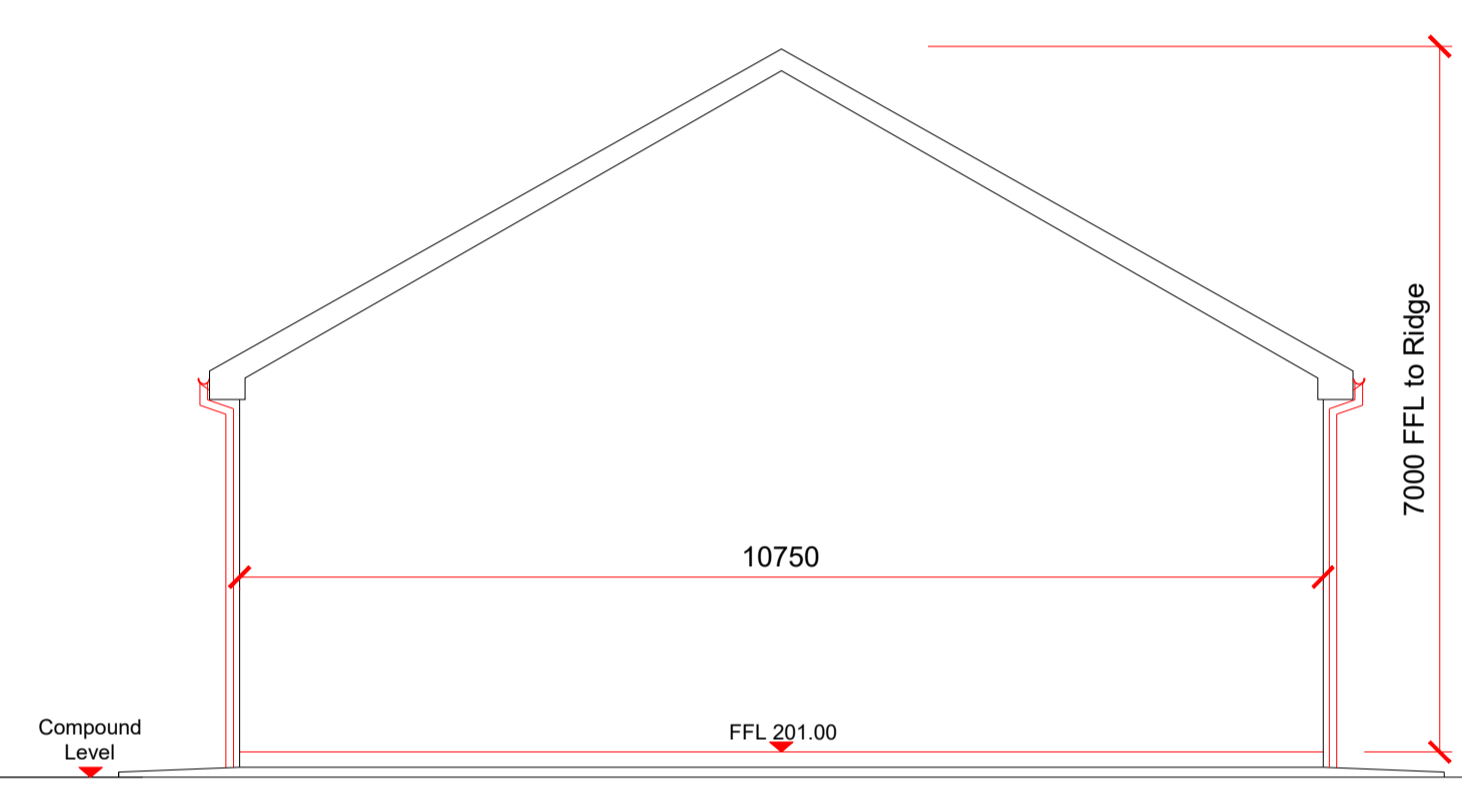

Side Elevation - Southwest Scale 1:75

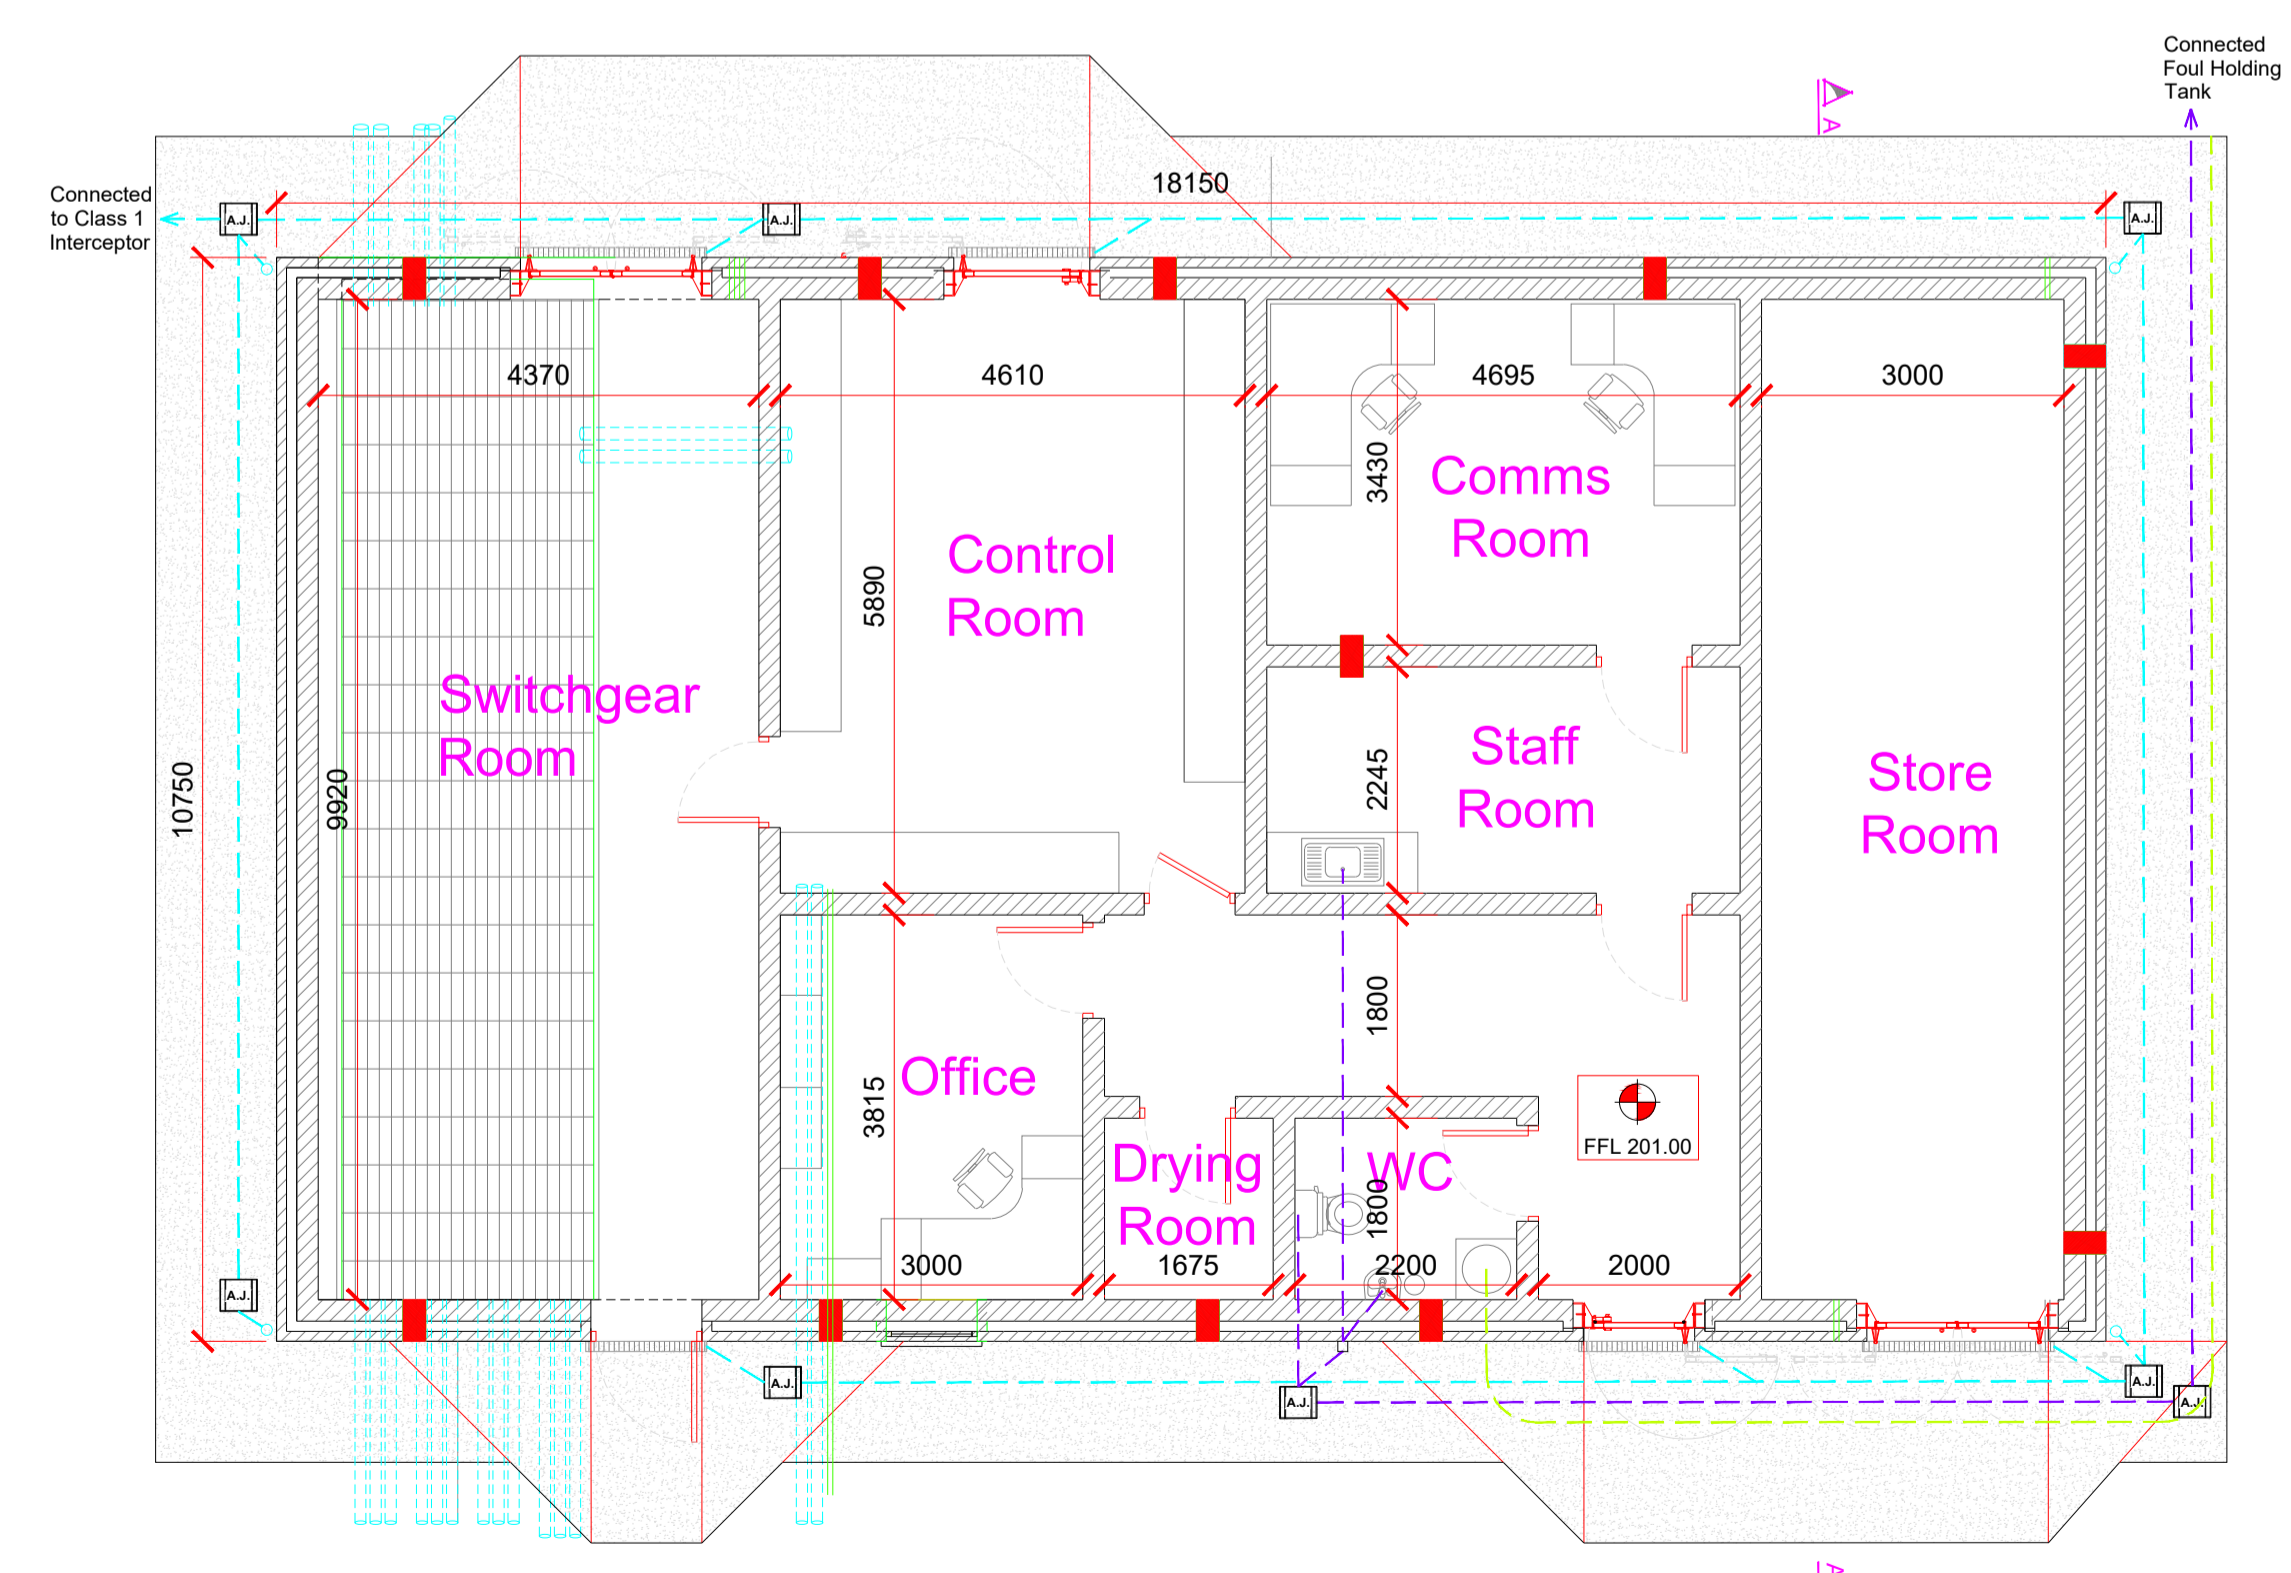

Plan Scale 1:75

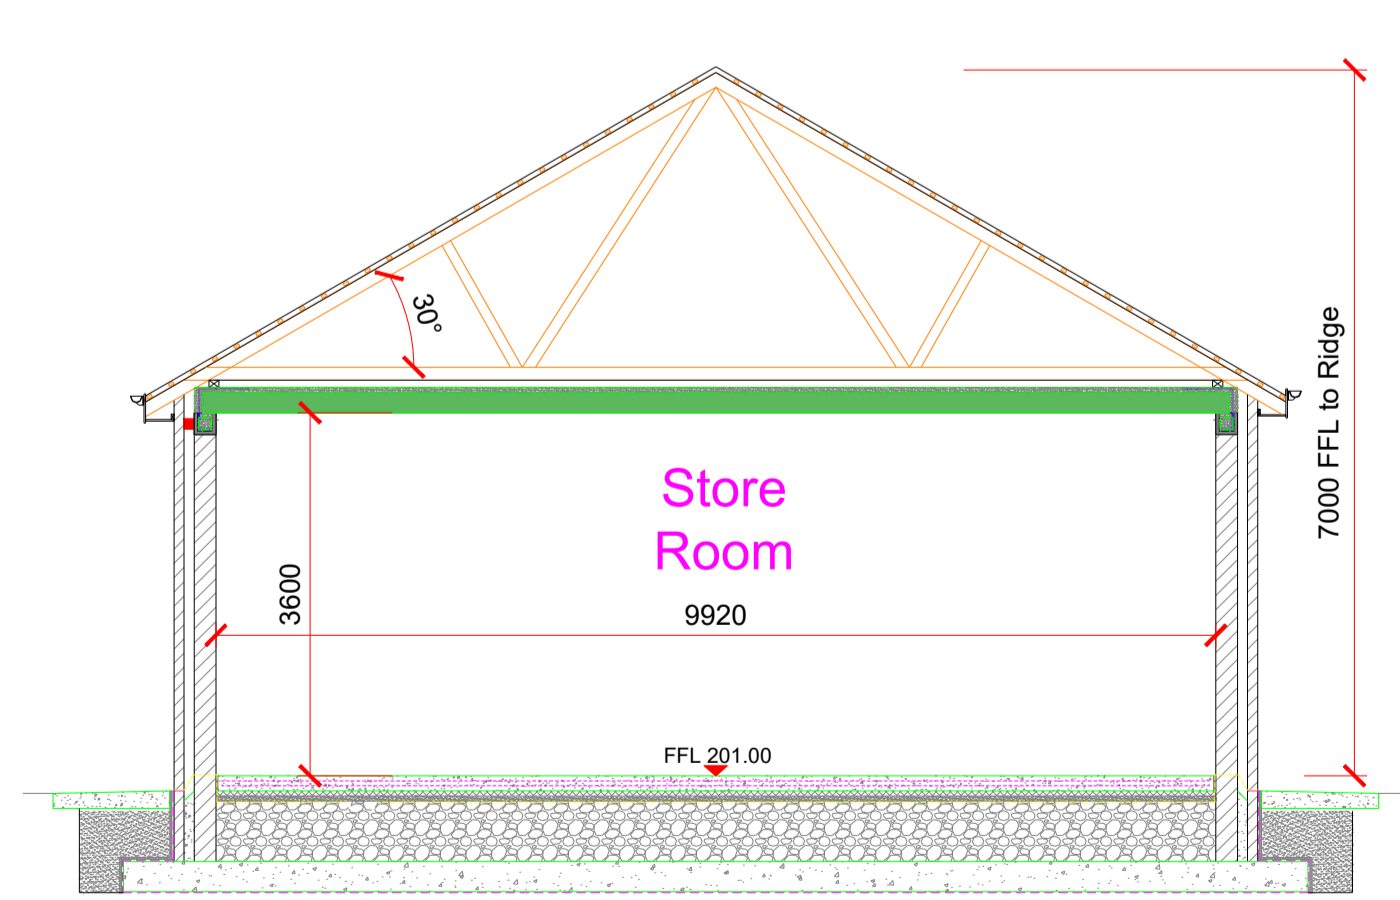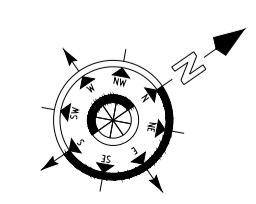

Section A-A Scale 1:75

LEGEND:

- Concrete Footpath (Impermeable)
- 100mm Ø uPVC Foul Water Pipe
- 100mm Ø uPVC Storm Water Pipe (Clean)
- 100mm Ø uPVC Storm Water Pipe (Dirty)
- Water Supply from Harvesting Tank
- Foul Water AJ
- Foul Water Manhole
- Storm Water AJ (Clean)
- Storm Water AJ (Dirty)

Rev.	Date	Description	JK	CM	HBR
A	03.07.2020	Issued For Planning			
Project: Carrowmagowan Wind Farm					
Title: IPP Substation Building Plan, Elevations & Section					
Client: COILLTE					
<p>Malachy Walsh and Partners Consulting Engineers Cork Tralee London Limerick</p> <p>Reen Point, Blennerville, Tralee, Co. Kerry Tel: +353 (0)66 7423404 Fax: +353 (0)66 7126586 E-mail: tralee@mwp.ie</p>					
Scales (A1) 1:75		Drg. No.		Rev.	
Drawn	NT	18.11.2019	19107-5053		A
Ch'd (DO)	JK	18.11.2019			
Ch'd (Eng)	CM	18.11.2019			
Approved	JL	18.11.2019			