



WTG Front Elevation
Scale 1:1,000

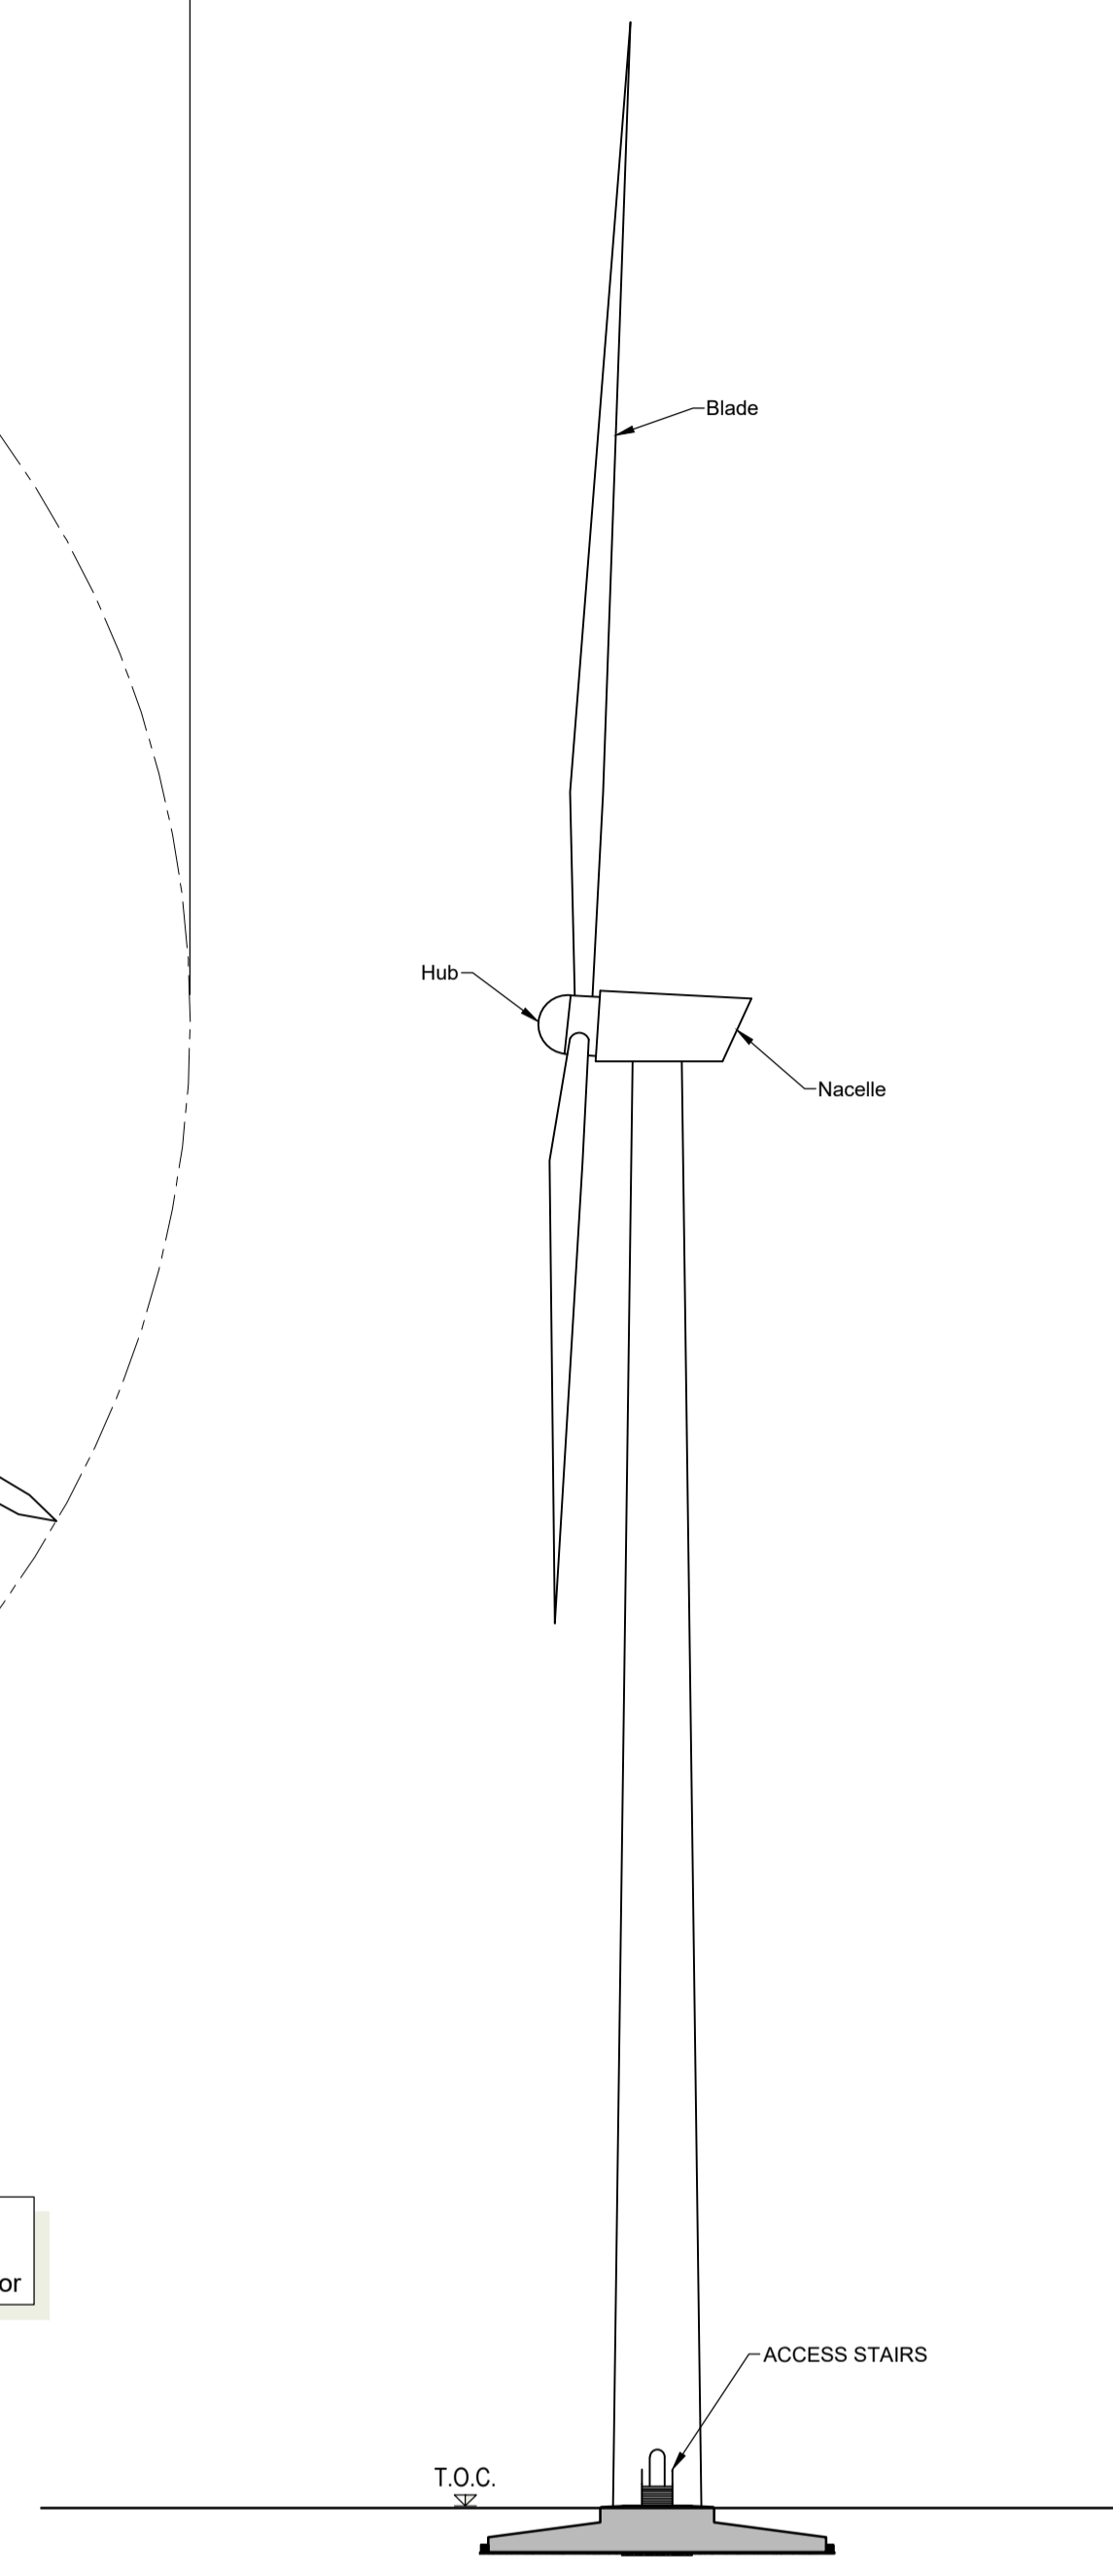


WTG Side Elevation
Scale 1:1,000


Note
 • T.O.C. = Top Of Concrete
 • WTG = Wind Turbine Generator

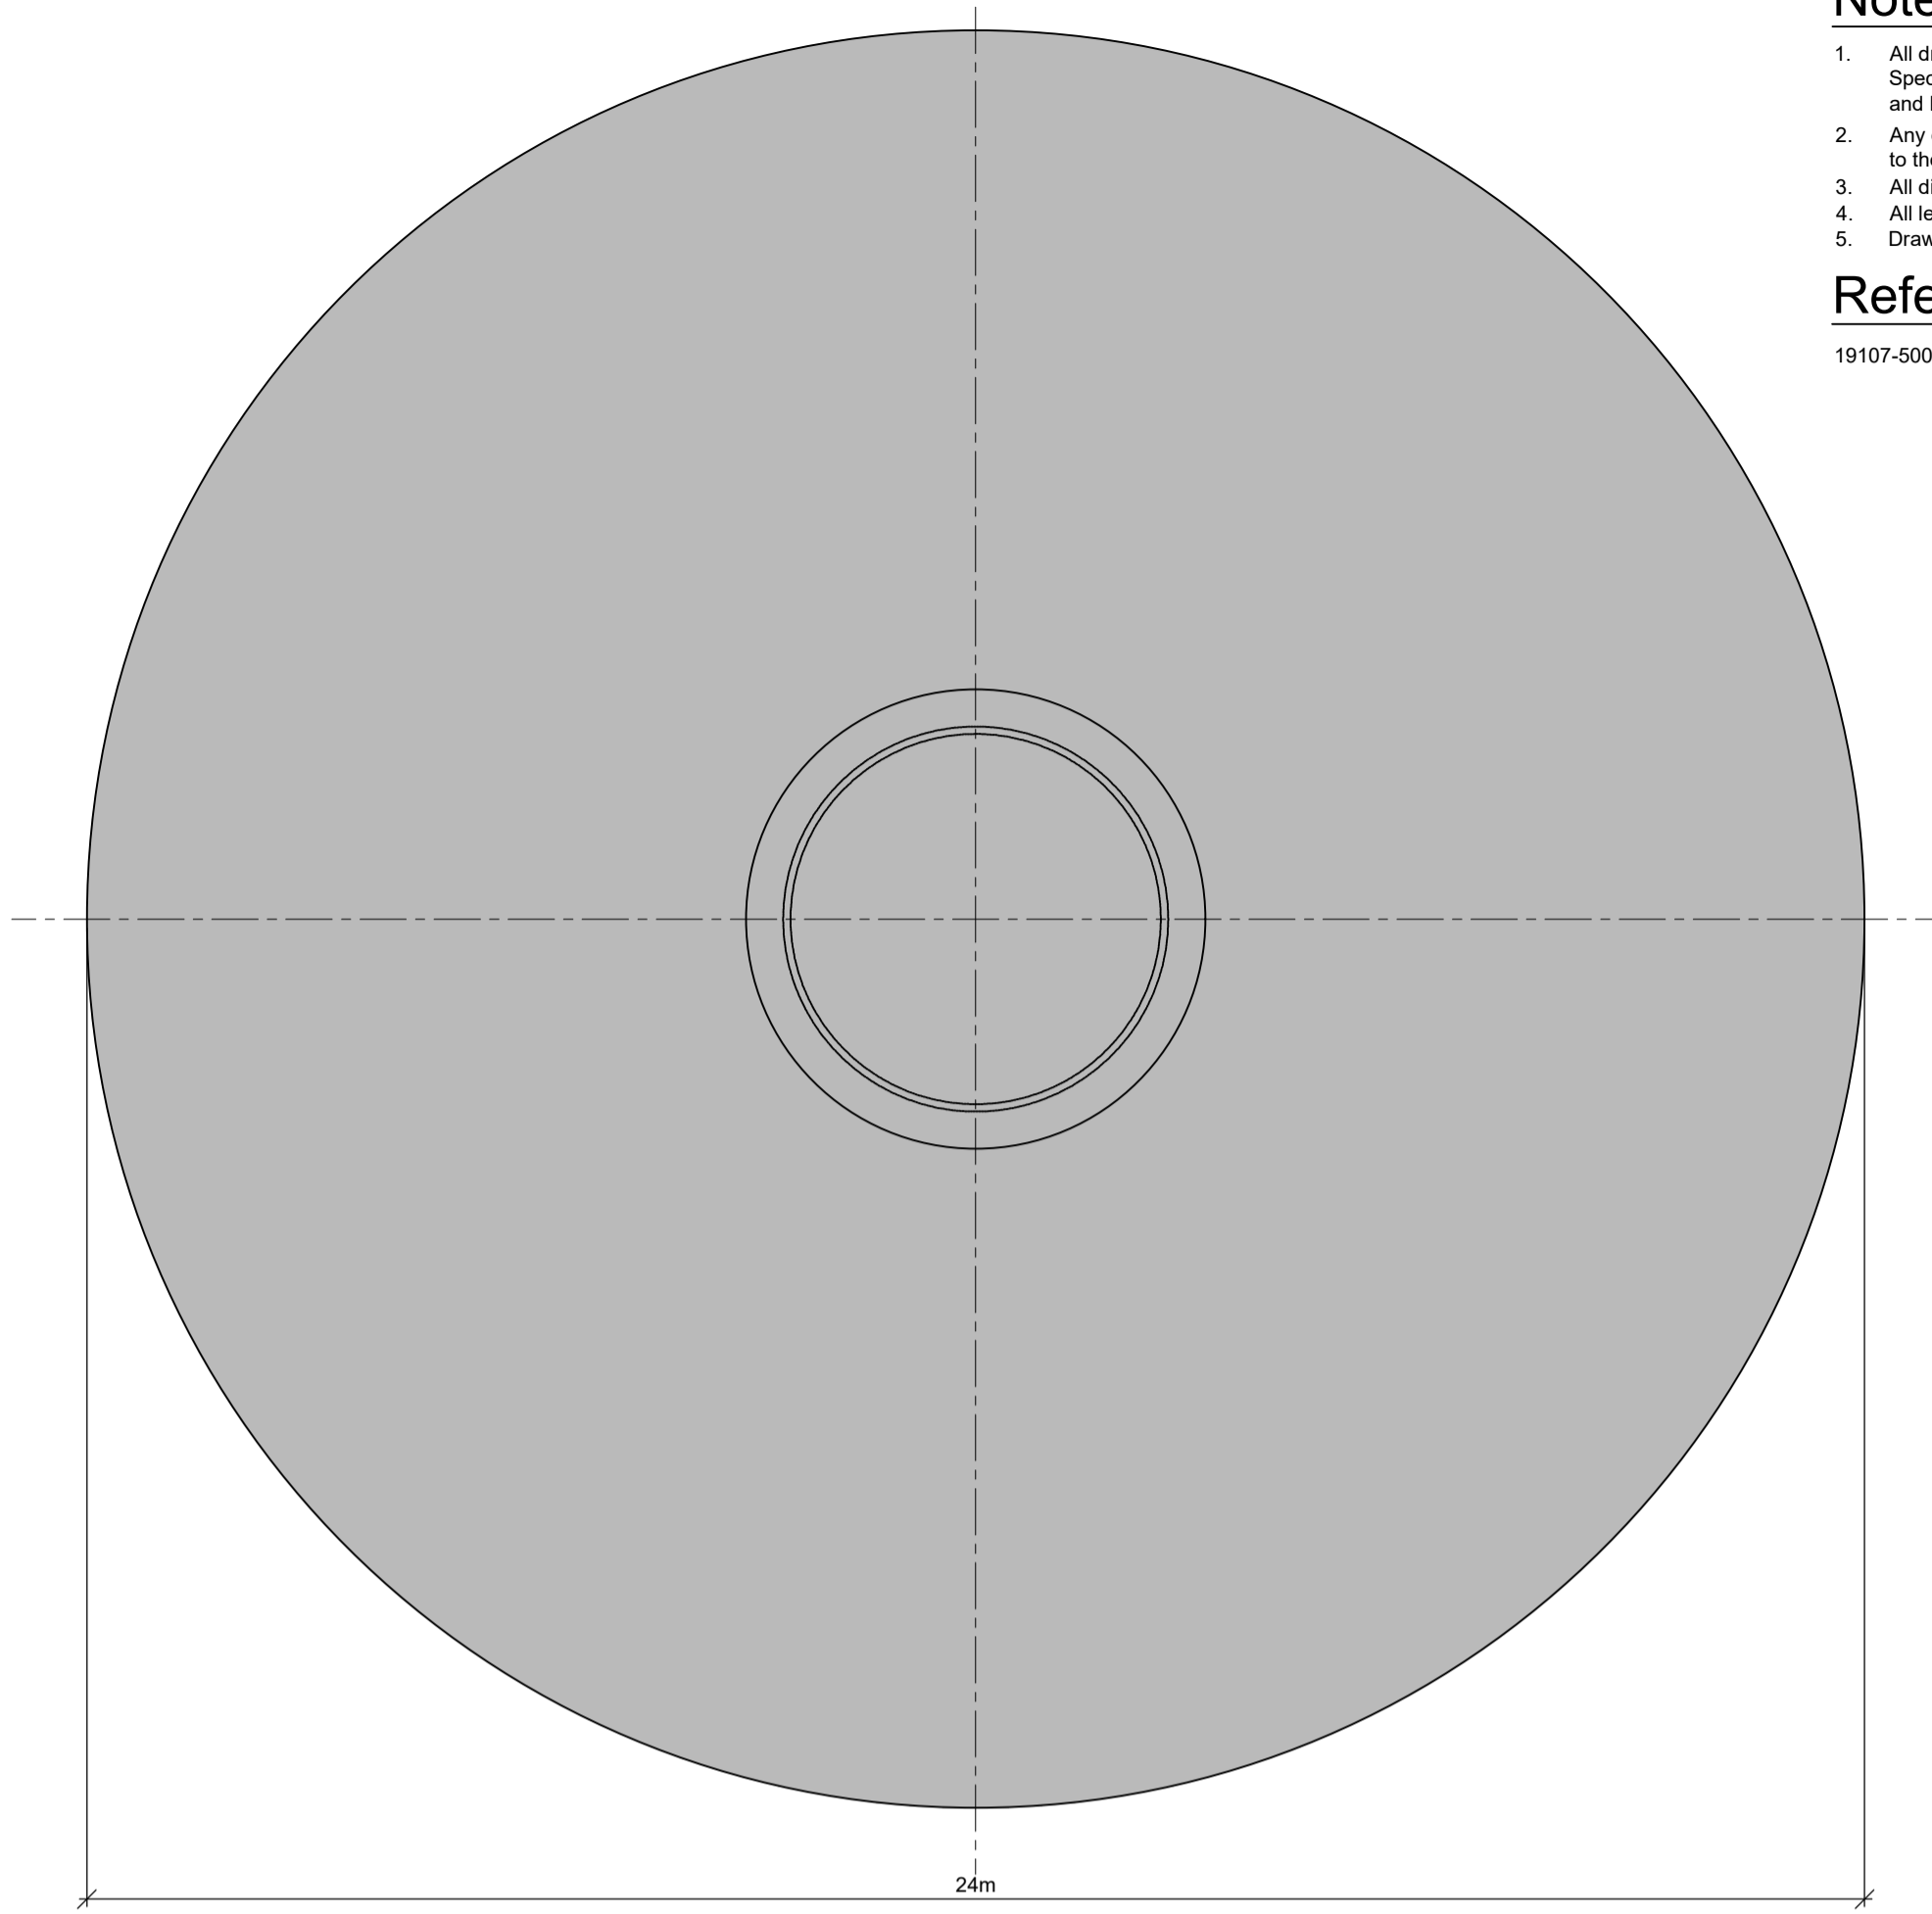


Plan View Of WTG Foundation Scale 1:100

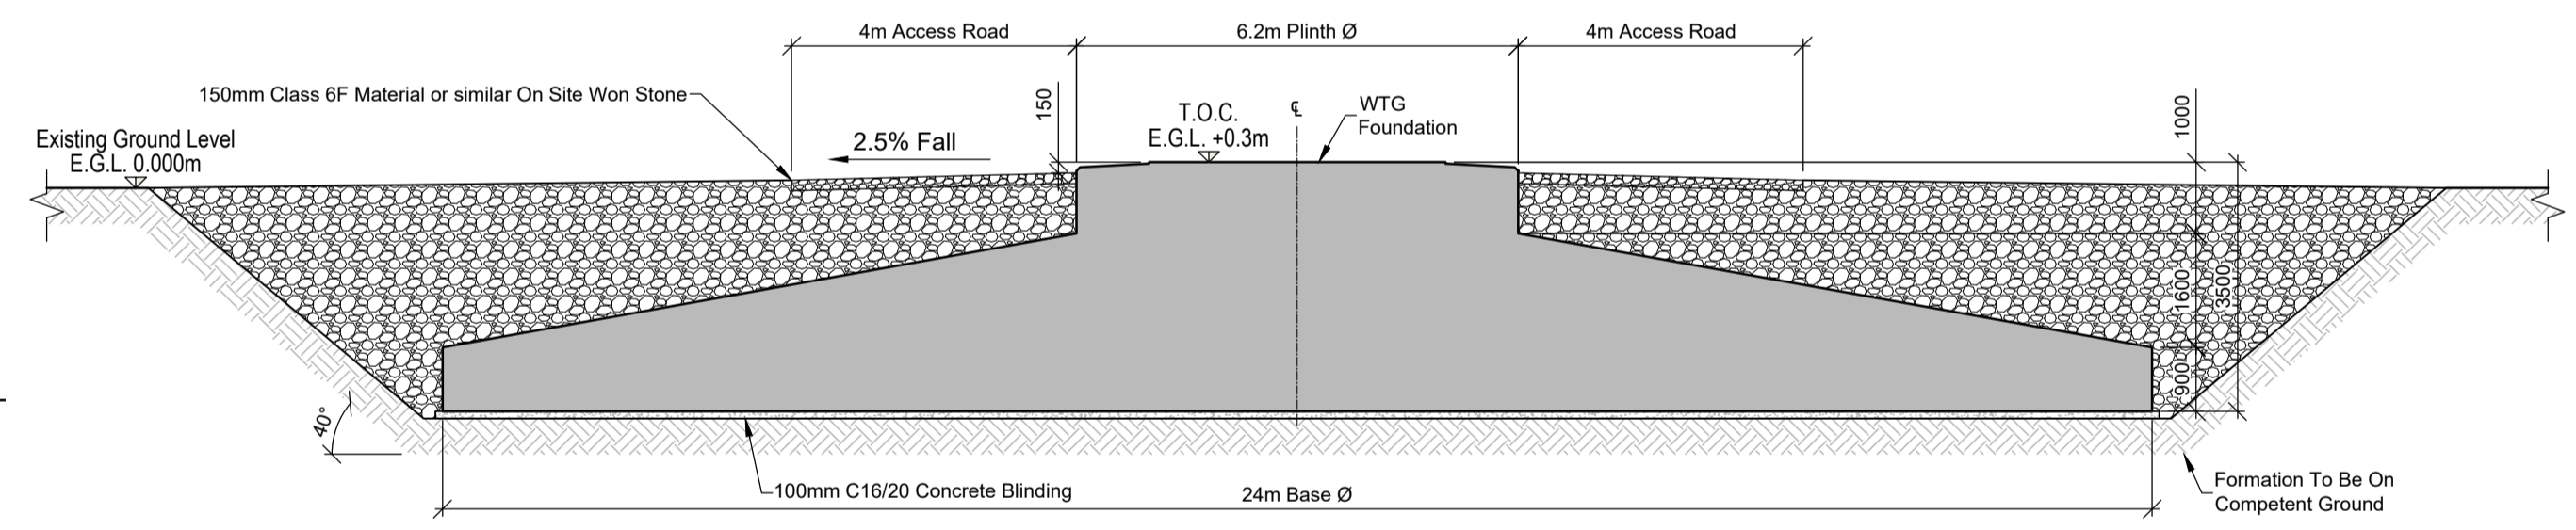

WTG Foundation Detail Scale 1:100

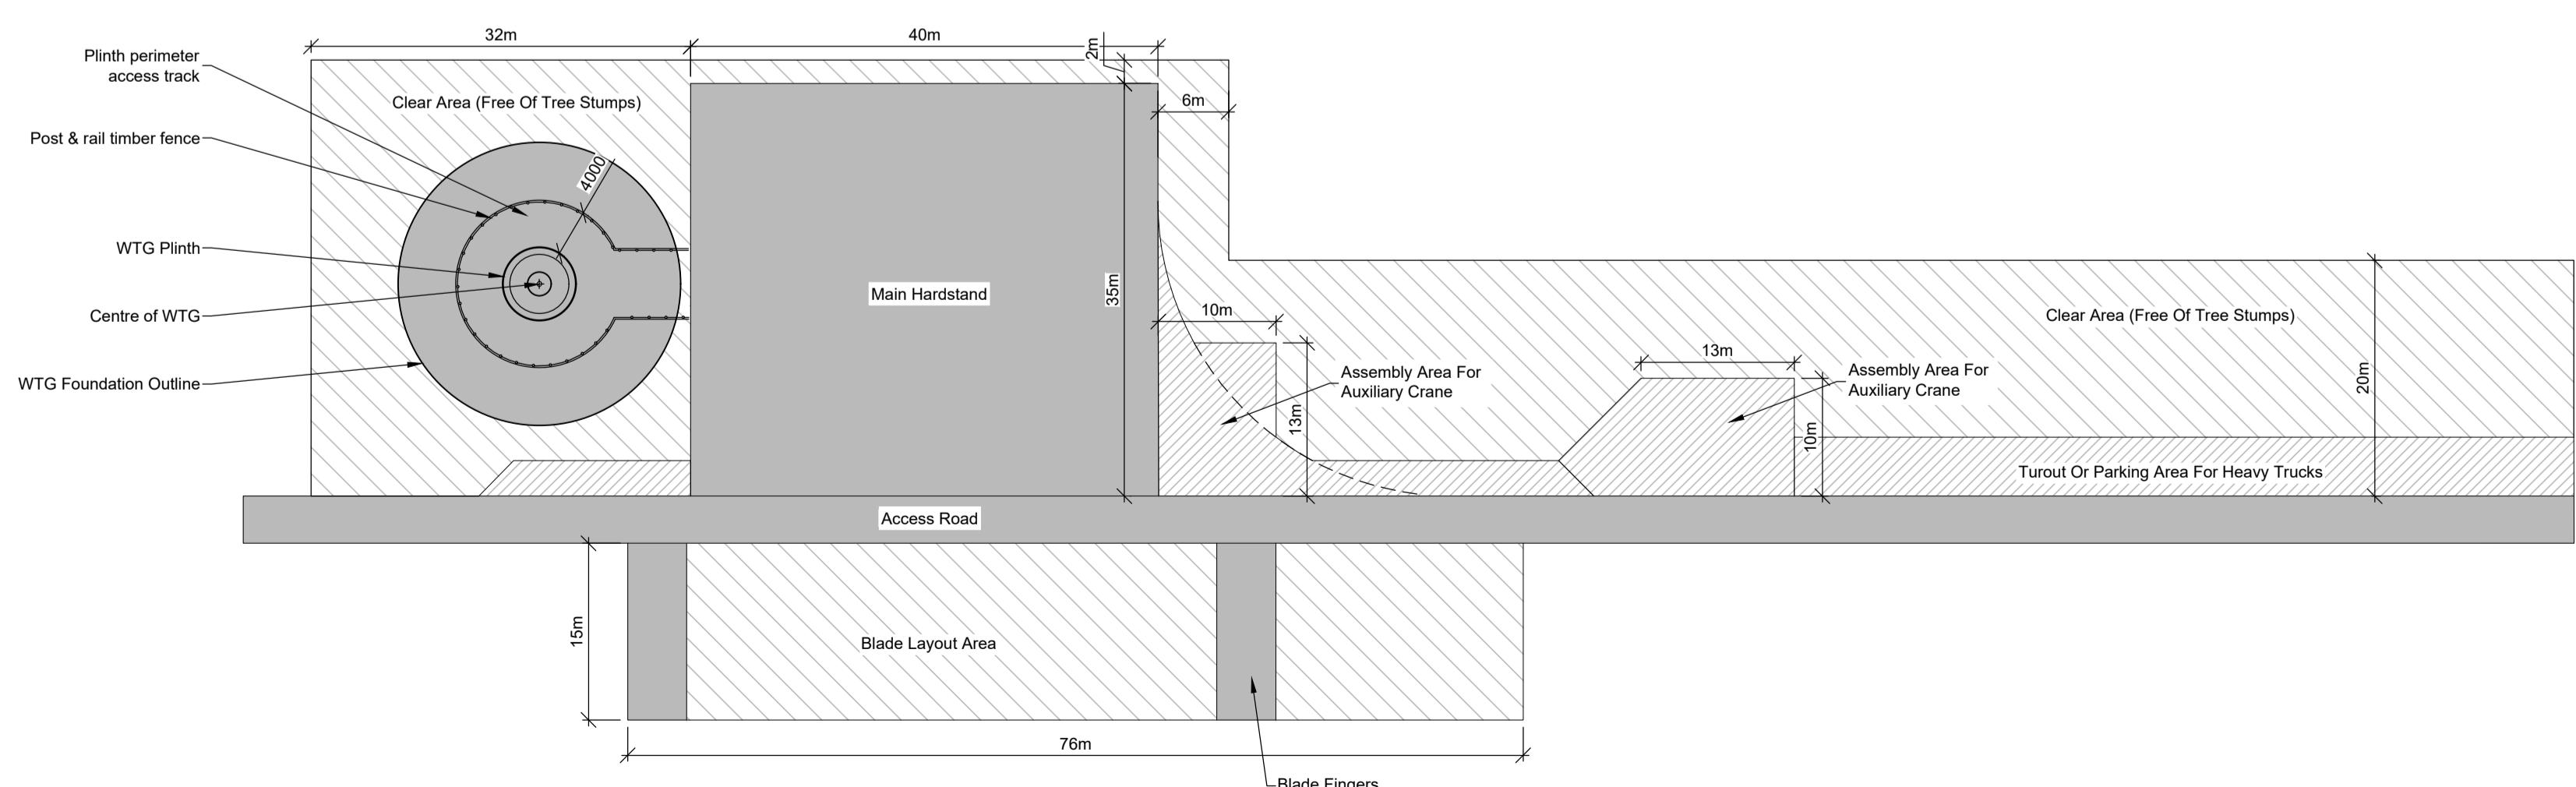

Hardstand Layout
Scale 1:500

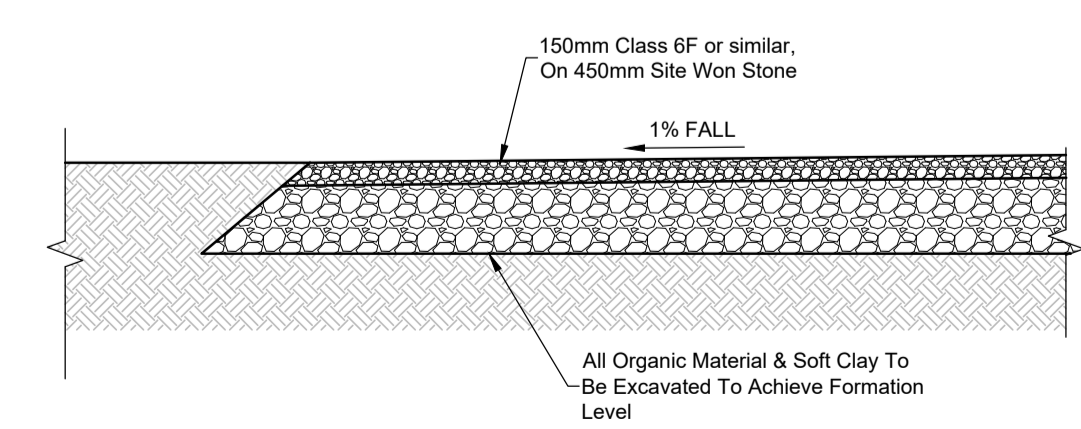

Hardstand Detail
Scale 1:50

- Notes :**
- All drawings are to be read in conjunction with all relevant Specifications, Bills of Quantities, Architectural, Services and Engineering drawings.
 - Any discrepancies between these documents shall be brought to the attention of the Engineer.
 - All dimensions are in millimetres, unless noted otherwise.
 - All levels are in metres related to Ordnance Datum.
 - Drawings are not to be scaled.

Reference Drawings :
19107-5005 Site Layout - Master Sheet

Rev.	Date	Issued For RFI	JK	KF	KF
A	21.12.2011	Issued For RFI	JK	KF	KF
Project Carrowagowan Wind Farm					
Title Turbine, Foundation And Hardstand Details					
Client COILLTE					
 Malachy Walsh and Partners Consulting Engineers Cork Tralee London Limerick					
Reen Point, Blennerville, Tralee, Co. Kerry.					
Tel: +353 (0)66 7423494 Fax: +353 (0)66 7126886 E-mail: tralee@mwp.ie					
Scales (A1) As Shown		Dwg. No.		Rev.	
Drawn	JK	21.12.2021	19107-5061		A
Ch'd (DO)	JK	21.12.2021			
Ch'd (Eng)	KF	21.12.2021			
Approved	KF	21.12.2021			